### Attachment 3 - Appendix A



To: Honorable Mayor & Town Council

From: Leslie Herman, Director of Parks & Recreation

Date: May 24, 2023

Subject: Vienna Annex Long-Term Use Study: Future of Existing Annex Building

Based on the May 8, 2023 Council conference session, Kimmel Bogrette Architecture & Kimley Horn (project team) and Council determined that the existing Annex has two viable outcomes.

- The first option (Option 1) and the project team's recommendation is to demolish the entire structure.
- The second option (Option 2) is to demolish the sanctuary and retain and renovate the gymnasium and supporting spaces.

<u>Option 1</u> - Council seemed to be generally in support of Option 1 - demo entire structure at a cost of \$250,000.

Option 2 - Council requested the project team provide the cost for Option 2 - to demolish the sanctuary and retain and renovate the gym and supporting spaces. The project team provided two rough construction estimates for retaining only the gym. The project team further explained that an additional 25% should be included if council wants to include soft costs, building permits, design, engineering, furniture and loose items like IT/AV, security, etc. for a total project cost. A detailed explanation of each option is included below and attached are floor plan diagrams showing the extent of the partial demo (keep the gym) options. Note the second sheet of each floor plan diagram includes the demo of the second floor.

- Option 2A Minimal Intervention, Partial Demolition, Gym to remain \$2,936,000
- Option 2B Concourse Renovation, Partial Demolition, Gym to remain \$3,346,600

<u>Action Item:</u> A decision needs to be made on the future of the Annex as the building is at the end of its useful life. The project team is requesting the Town Council vote at the June 5, 2023 council meeting the option they prefer – Option 1, Option 2A or Option 2B. This decision making will:

- Provide direction to the project team on how to proceed with the existing Annex.
- Inform decision making to the Town's budget committee and Council when considering various options for long-term use as part of the Capital Improvement Plan (CIP) in September. This will begin the discussion for long-term use.

### ANNEX VIABLE OUTCOMES WITH COST IMPLICATIONS

### Option 1: Demolition of Entire Building (\$250,000)


- Rough ballpark pricing for demolition and removal of debris of the entire building as one. Estimate \$250,000.
- Estimated pricing includes;
  - Disconnecting sewer/water utilities (Gas and Electric will need to be disconnected by the owner of the property)
  - o Demolition of Structure/Removal of Debris
  - Erosion Controls
  - o Importing Dirt to fill in where structure has been removed
  - Grading of imported dirt to provide positive drainage
  - Stabilization of disturbed area with seed/straw
  - o Does not include removal of asphalt driveway / parking lot or tree removal.
  - Civil engineering
  - County Fees

### Option 2A: Minimal Intervention, Partial Demolition, Gymnasium to remain. (\$2,936,000)

- Selective Demolition: \$50 per sf (\$656,000)
  - o Demo 10,667 SF on the first level & the entire 2,453 SF on the second level. This eliminates the sanctuary, existing plumbing and mechanical spaces, and adjacent office spaces. By removing the second level, we eliminate the need to add an elevator to make the level accessible.
- Renovation: \$250 per sf (\$2,030,000)
  - 8,120 SF of the gymnasium and support spaces directly north. The improvements should include new flooring, wall, and ceiling finishes in the gymnasium. The exterior walls will need to be patched with masonry and the entire building should get parged & painted. A mural can be painted on the gymnasium elevation facing Waters Field. The roof membrane and insulation will get replaced. A male and female locker room will be fitted in the northern storage spaces. The electric and mechanical systems will be completely replaced.
- Site Improvements: (\$250,000 Allowance)
  - The parking lot & drive isles will remain and get patched and repaired as required. The areas of demolition shall get regraded and grass seed planted. The entrances shall get planted and any future residential screening plants should get planted in this phase.

### Option 2B: Concourse Renovation, Partial Demolition, Gymnasium to remain. (\$3,346,600)

- Selective Demolition: \$50 per sf (\$524,600)
  - o 8,039 SF on the first level & the entire 2,453 SF on the second level. This eliminates the sanctuary, existing plumbing, and mechanical spaces, two story office and adjacent office spaces. By removing the second level, we eliminate the need to add an elevator to make the level accessible.
- Renovation: \$250 per sf (\$2,270,000)
  - 9,080 SF of the gymnasium and support spaces directly north. The improvements should include new flooring, wall, and ceiling finishes in the gymnasium. The exterior brick walls will get patched, repointed, & sealed. The roof membrane and insulation will get replaced. A male and female locker room will be fitted in the southern office space. The electric and mechanical systems will be completely replaced.
- Renovation with New Façade & Roof: \$300 per SF (\$552,000)
  - o 1,840 SF of concourse connection space. The exterior walls would be mostly demolished and replaced with a modern glass façade that wraps 2 sides of the gymnasium. The roof would be replaced to gain some additional height in the public spaces and cover up areas of the exterior that would be damaged during demolition of the connecting spaces.
- Site Improvements: (\$250,000 Allowance)
  - The parking lot & drive isles will remain and get patched and repaired as required. The areas of demolition shall get regraded and grass seed planted. The entrances shall get flower beds and any residential screening plants should get planted in this phase.

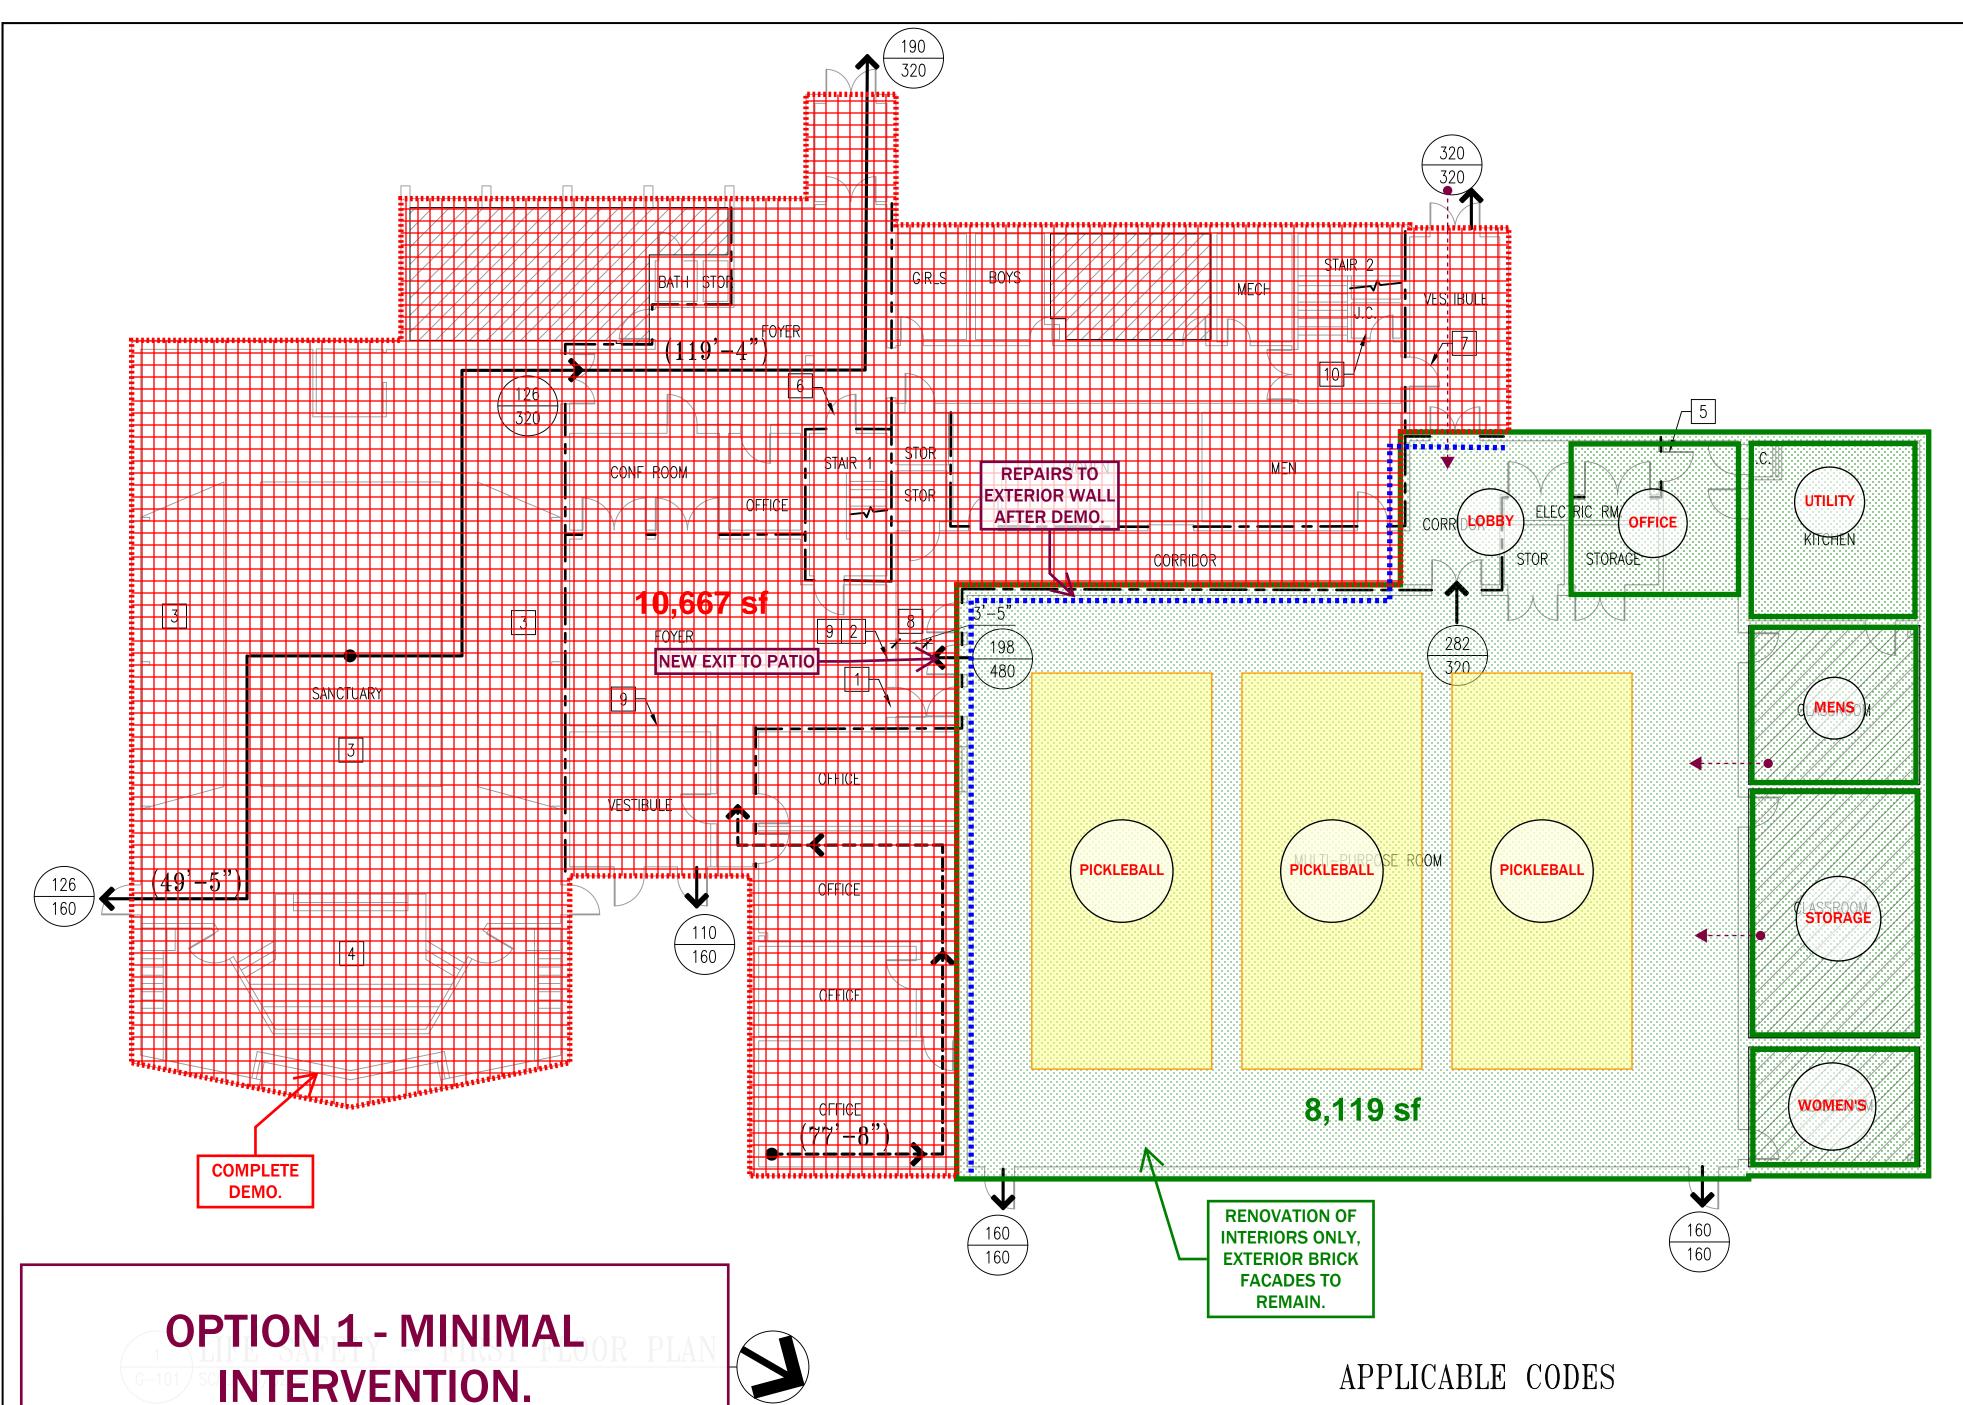

VIRGINIA EXISTING BUILDING CODE (VEBC), 2018 VIRGINIA FIRE PREVENTION CODE. ICC A117.1 AMERICANS WITH DISABILITIES ACT (ADA).

| BUILDING                      | CODE SUM             | IMARY        |       |
|-------------------------------|----------------------|--------------|-------|
| BUILDING CODE                 | INTERNATIONAL BUILDI | NG CODE (IBC | 2018) |
| FIRE RESISTANCE               | REQUIRED             | PROVIDED     | UL    |
| STRUCTURAL FRAME              | 0                    | 0            |       |
| BEARING WALL (EXT/INT)        | 0/0                  | 0/0          |       |
| NON-BEARING EXT WALL X>=10 FT | 0                    | 0            |       |
| FLOOR CONSTRUCTION            | 0                    | 0            |       |
| ROOF CONSTRUCTION             | 0                    | 0            |       |
| STAIR SHAFTS                  | 1                    | 2            |       |
| ELEVATOR & MISC SHAFTS        | 1                    | N/A          |       |
| CORRIDOR WALLS                | 0                    | 0            |       |

| BUILDING CODE             | SUMMARY  |
|---------------------------|--|
| BUILDING CODE             | IEBC 2015 / IBC 2018                             |
| TYPE OF CONSTRUCTION      | TYPE VB, NON COMBUSTIBLE,<br>UNPROTECTED         |
| OCCUPANCY                 | ASSEMBLY A-3<br>ALLOWED PROVIDED                 |
| STORIES                   | 1 2  |
| HEIGHT                    | 40 40  |
| FIRST FLOOR               | 6,000 SF 18,702 SF                               |
| TOTAL GROSS BUILDING AREA | FIRST FLOOR: 18.702 SF<br>SECOND FLOOR: 2,511 SF |
|                           | TOTAL: 21,213 SF                                 |


| EGRESS SUMMARY                         |   |  |  |
|--|---|--|--|
| BUILDING CODE                          | NFPA 101 2018 ED REQUIRED<br>IBC 2018 ED REQUIRED |  |  |
| DOOR WIDTH IN INCHES ( MIN 32 INCHES)  | 32 INCHES   |  |  |
| STAIR EGRESS WIDTH IN INCHES (MIN 48") | 48 INCHES / 66 INCHES                             |  |  |
| MIN NUMBER OF EXITS                    | 4   |  |  |
| MAX EXIT TRAVEL DISTANCE IN FEET       | (A-3) 200   |  |  |
| MAX COMMON PATH OF TRAVEL IN FEET      | (A-3) 75  |  |  |
| MAX DEAD-END CORRIDOR LENGTH IN FEET   | 20 FEET   |  |  |
|  |   |  |  |

## GENERAL CODE REVIEW

- 1. WORK IS CONSIDERED "CHANGE OF OCCUPANCY" PER VA UNIFORM STATEWIDE BLDG. CODE 2018
- 2. SOME EXISTING PARTITIONS APPEAR TO BE RATED DUE TO PRESENCE OF LABELED DOORS BUT ARE NOT HEREBY

### SHEET KEYNOTES

- DOOR NOT PERMITTED TO SWING TOWARD THE MULTIPURPOSE ROOM.
- ADDITIONAL DOOR IS REQUIRED IN THIS WALL TO MEET MINIMUM REQUIRED EGRESS CAPACITY.
- SANTUARY SEATING BENCHES WITH OCCUPANT LOAD CALCULATED AT 1 PER 18" OR BENCH LENGTH.
- EXISTING STAGE WITHOUT PROSCENIUM (ALTAR).
- NOT A REQUIRED MEANS OF EGRESS
- OCCUPANT LOAD FROM SECOND STORY = 31. EGRESS THROUGH FOYER.
- OCCUPANT LOAD FROM SECOND STORY = 31. EGRESS THROUGH VESTIBULE.
- MINIMUM 48" CLEAR FROM DOOR OPEN AS SHOWN TO OPPOSITE WALL NOT MET.
- EXISTING WALLS DIVIDE WHAT APPEARS TO HAVE BEEN A RATED EGRESS CORRIDOR.
- JANITOR'S CLOSET (OR ANY STORAGE OR OTHER FUNCTION) NOT PERMITTED IN STAIRWELLS.

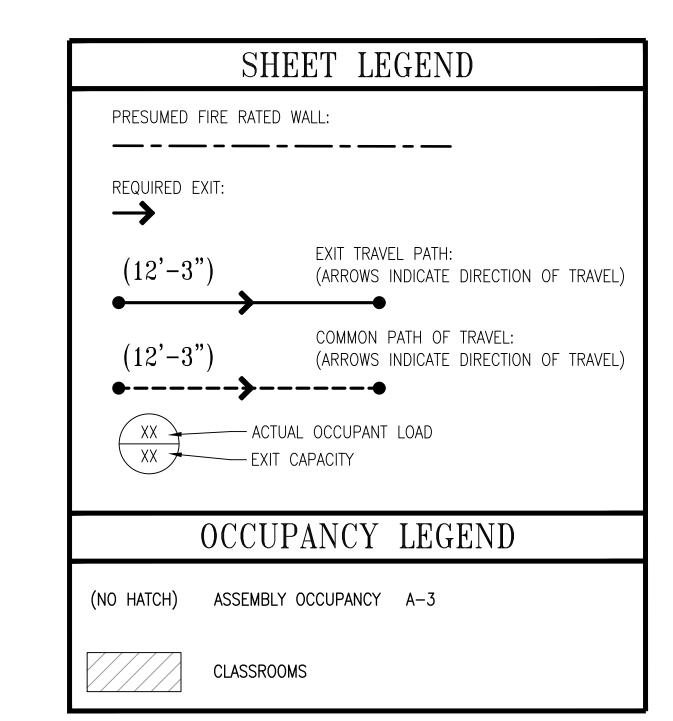

| CODE OCC                              | CUPANT    | LOAD - FI    | LOOR 1    |
|---------------------------------------|-----------|--------------|-----------|
| SPACE FUNCTION                        | AREA      | OCCUPANT /SF | OCCUPANCY |
| SANCTUARY (ASSEMBLY W/ FIXED SEATING) | 3,523 SF  | N/A          | 252       |
| GYMNASIUM /<br>MULTI-PURPOSE          | 5440 SF   | 7            | (700) 800 |
| CLASSROOMS                            | 1757 SF   | 20           | 88        |
| STORAGE                               | 300 SF    | 300          | 1         |
| BUSINESS                              | 7,952 SF  | 150          | 53        |
| TOTAL                                 | 18,702 SF |              | 1,194     |

| REVISIONS |  |  |
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CLIENT INFORMATION

TOWN OF VIENNA PARKS AND RECREATION

FBC CODE REVIEW

KEY PLAN GRAPHIC SCALES

SCALE: 3/32" = 1'-0"

SIGNATURE

PROFESSIONAL CERTIFICATION. CERTIFY THAT THESE DOCUMENTS WERE PREPARED OR APPROVED BY ME, AND THAT I AM A DULY LICENSED ARCHITECT UNDER THE LAWS OF THE STATE OF MARYLAND, LICENSE NO. 12345 EXPIRATION DATE: XX/XX/XXXX




Whitman, Requardt & Associates, LLP 801 South Caroline Street, Baltimore, Maryland 21231

> FIRST FLOOR CODE ANALYSIS PLAN

> > DRAWING NO.

SCALE: 3/32" = 1'0" SHEET 1 OF 2 DES: **EL** DRAWN: **AJM** CHECK: **EBL** 

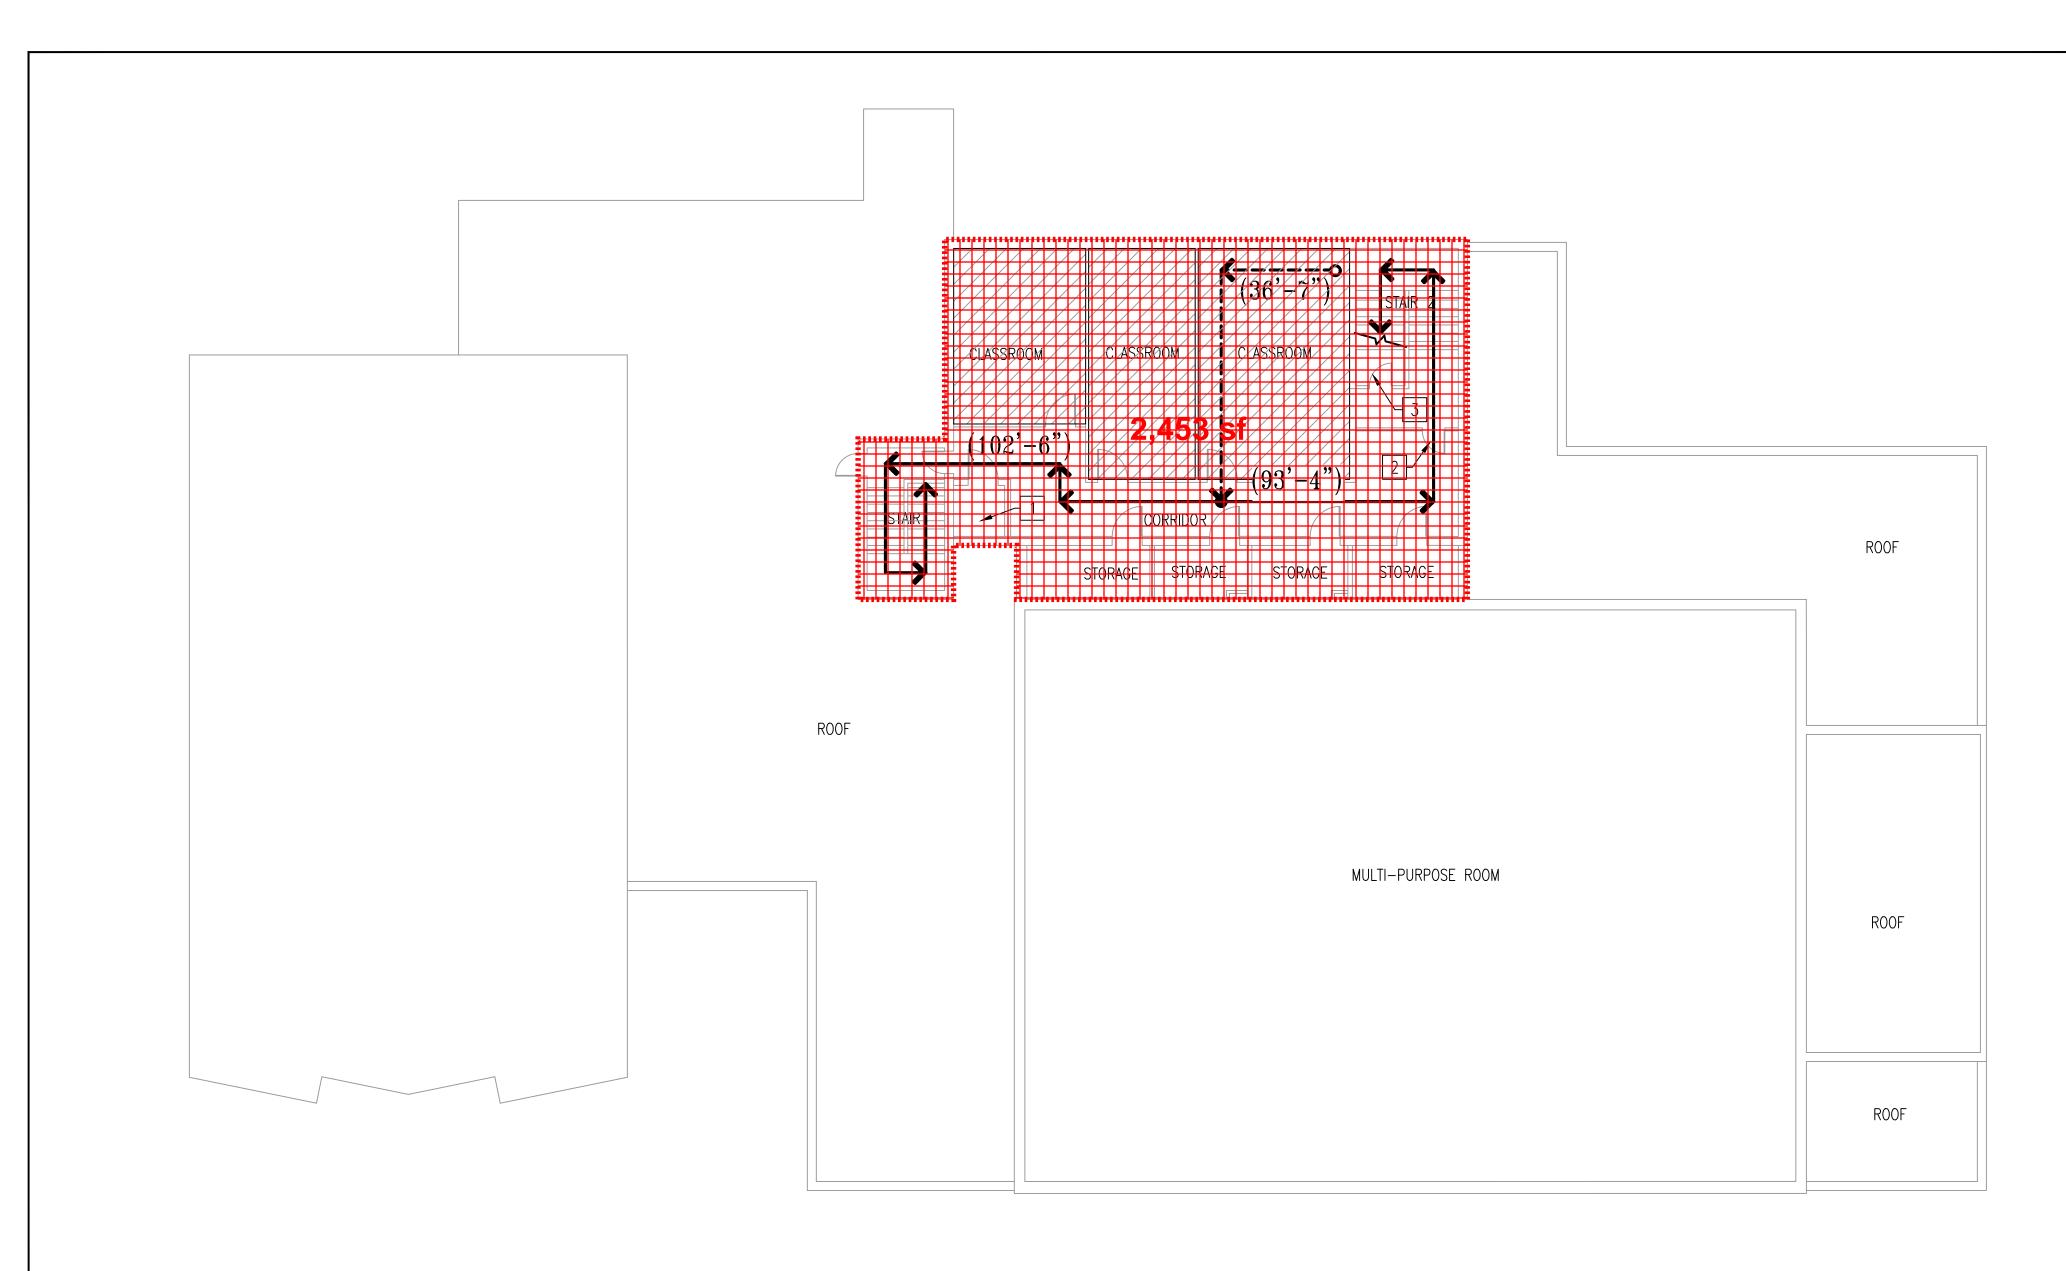



| BUILDING                     | CODE          | SUN     | <b>IMARY</b> | [        |      |
|------------------------------|---------------|---------|--------------|----------|------|
| BUILDING CODE                | 2018 VIRGINIA | UNIFORM | STATEWIDE    | BUILDING | CODE |
| FIRE RESISTANCE              | RE            | EQUIRED | PROVIDED     | UL       |      |
| STRUCTURAL FRAME             |               | 0       | 0            |          |      |
| BEARING WALL (EXT/INT)       |               | 0/0     | 0/0          |          |      |
| NON-BEARING EXT WALL X>=10 F | Т             | 0       | 0            |          |      |
| FLOOR CONSTRUCTION           |               | 0       | 0            |          |      |
| ROOF CONSTRUCTION            |               | 0       | 0            |          |      |
| STAIR SHAFTS                 |               | 1       | 1            |          |      |
| ELEVATOR & MISC SHAFTS       |               | 1       | 1            |          |      |
| CORRIDOR WALLS               |               | 0       | 0            |          |      |

| BUILDING CODE             | SUMMARY  |
|---------------------------|--|
| BUILDING CODE             | 2018 VIRGINIA UNIFORM<br>STATEWIDE BUILDING CODE |
| TYPE OF CONSTRUCTION      | TYPE VB, NON SPRINKLERED,<br>UNPROTECTED         |
| OCCUPANCY                 | ASSEMBLY A-3<br>ALLOWED PROVIDED                 |
| STORIES                   | 1 2  |
| HEIGHT                    | 40 40  |
| SECOND FLOOR              | 6,000 SF 2,511 SF                                |
| TOTAL GROSS BUILDING AREA | FIRST FLOOR: 18.702 SF<br>SECOND FLOOR: 2,511 SF |
|                           | TOTAL: 21,213 SF                                 |

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|   | EGRESS SUMM                            | IARY   |
|   | BUILDING CODE                          | 2018 VIRGINIA UNIFORM STATEWIDE<br>BUILDING CODE |
|   | DOOR WIDTH IN INCHES ( MIN 32 INCHES)  | 32 INCHES  |
|   | STAIR EGRESS WIDTH IN INCHES (MIN 48") | 48 INCHES / 66 INCHES                            |
|   | MIN NUMBER OF EXITS                    | 2  |
|   | MAX EXIT TRAVEL DISTANCE IN FEET       | (A-3) 200  |
|   | MAX COMMON PATH OF TRAVEL IN FEET      | (A-3) 75   |
|   | MAX DEAD-END CORRIDOR LENGTH IN FEET   | 20 FEET  |
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## GENERAL CODE REVIEW


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## SHEET KEYNOTES

- NON-RATED STORAGE ROOM NOT PERMITTED WITHIN RATED EGRESS CORRIDOR.
- WALL DOES NOT APPEAR TO BE RATED AS REQUIRED FOR STAIR ENCLOSURE.
- JANITOR'S CLOSET (OR ANY STORAGE OR OTHER FUNCTION)
  NOT PERMITTED IN STAIRWELLS.

## APPLICABLE CODES

VIRGINIA EXISTING BUILDING CODE (VEBC), 2018
VIRGINIA FIRE PREVENTION CODE.
ICC A117.1
AMERICANS WITH DISABILITIES ACT (ADA).

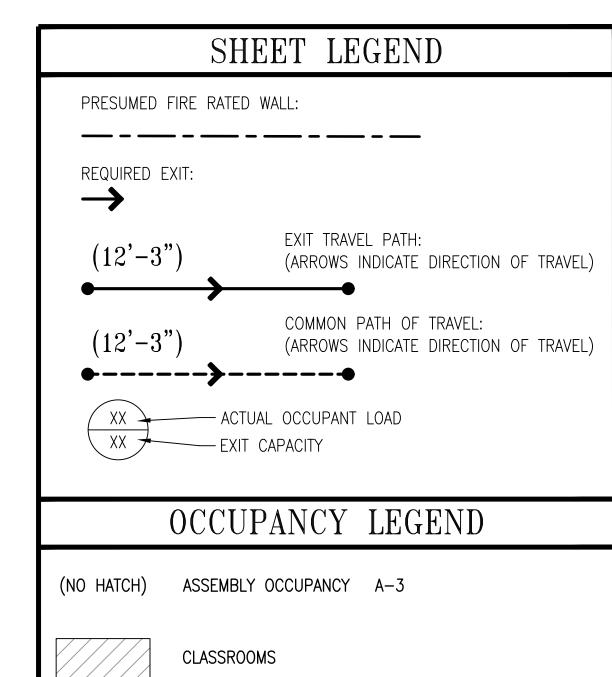

| CODE OCC             | CUPANT   | LOAD - FI    | LOOR 1    |
|----------------------|----------|--------------|-----------|
| SPACE FUNCTION       | AREA     | OCCUPANT /SF | OCCUPANCY |
| CLASSROOMS           | 1,022 SF | 20           | 52        |
| STORAGE / MECHANICAL | 305 SF   | 300          | 2         |
| BUSINESS             | 1,184 SF | 150          | 8         |
| TOTAL                | 2,511 SF |              | 62        |

| REVISIONS |  |  |
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CLIENT INFORMATION

TOWN OF VIENNA
PARKS AND
RECREATION

FBC CODE REVIEW

| KEY PLAN  |
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| GRAPHIC SCALES  0 4' 8' 12' 20'  SCALE: 3/32" = 1'-0" |
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| SIGNATURE   |
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A DULY LICENSED ARCHITECT UNDER THE LAWS OF THE STATE OF MARYLAND, LICENSE NO. 12345
EXPIRATION DATE: XX/XX/XXXX

PREPARED OR APPROVED BY ME, AND THAT I AM

PROFESSIONAL CERTIFICATION.

I CERTIFY THAT THESE DOCUMENTS WERE



Whitman, Requardt & Associates, LLP 801 South Caroline Street, Baltimore, Maryland 21231

SECOND FLOOR CODE ANALYSIS PLAN


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DATE: SHEET 2 OF 2

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# **OPTION 2 - CONCOURSE** RENOVATION.



### BUILDING CODE SUMMARY INTERNATIONAL BUILDING CODE (IBC 2018) BUILDING CODE FIRE RESISTANCE REQUIRED PROVIDED UL STRUCTURAL FRAME BEARING WALL (EXT/INT) 0/0 0/0 NON-BEARING EXT WALL X>=10 FT FLOOR CONSTRUCTION ROOF CONSTRUCTION STAIR SHAFTS ELEVATOR & MISC SHAFTS N/A CORRIDOR WALLS

| BUILDING CODE  IEBC 2015 / IBC 2018  TYPE VB, NON COMBUSTIBLE, UNPROTECTED  ASSEMBLY A-3 ALLOWED PROVIDED  STORIES  1 2 HEIGHT 40 40  FIRST FLOOR FIRST FLOOR FIRST BUILDING AREA  FIRST FLOOR: 18,702 SF SECOND FLOOR: 2,511 SF TOTAL: 21,213 SF | BUILDING CODE             | SUMMARY              |
|---|---------------------------|----------------------|
| TYPE OF CONSTRUCTION  OCCUPANCY  ASSEMBLY A-3 ALLOWED PROVIDED  STORIES  1 2 HEIGHT  40 40  FIRST FLOOR  FIRST FLOOR  TOTAL GROSS BUILDING AREA  FIRST FLOOR: 18.702 SF SECOND FLOOR: 2,511 SF  | BUILDING CODE             | IEBC 2015 / IBC 2018 |
| OCCUPANCY  STORIES  1 2  HEIGHT  40  FIRST FLOOR  FIRST FLOOR  TOTAL GROSS BUILDING AREA  FIRST FLOOR: 18.702 SF SECOND FLOOR: 2,511 SF   | TYPE OF CONSTRUCTION      | 1                    |
| HEIGHT 40 40  FIRST FLOOR 6,000 SF 18,702 SF  TOTAL GROSS BUILDING AREA FIRST FLOOR: 18.702 SF SECOND FLOOR: 2,511 SF   | OCCUPANCY                 |                      |
| FIRST FLOOR 6,000 SF 18,702 SF  TOTAL GROSS BUILDING AREA FIRST FLOOR: 18.702 SF SECOND FLOOR: 2,511 SF   | STORIES                   | 1 2                  |
| TOTAL GROSS BUILDING AREA  FIRST FLOOR: 18.702 SF SECOND FLOOR: 2,511 SF  | HEIGHT                    | 40 40                |
| SECOND FLOOR: 2,511 SF  | FIRST FLOOR               | 6,000 SF 18,702 SF   |
| TOTAL: 21,213 SF  | TOTAL GROSS BUILDING AREA |                      |
| <u> </u>  | _                         | TOTAL: 21,213 SF     |
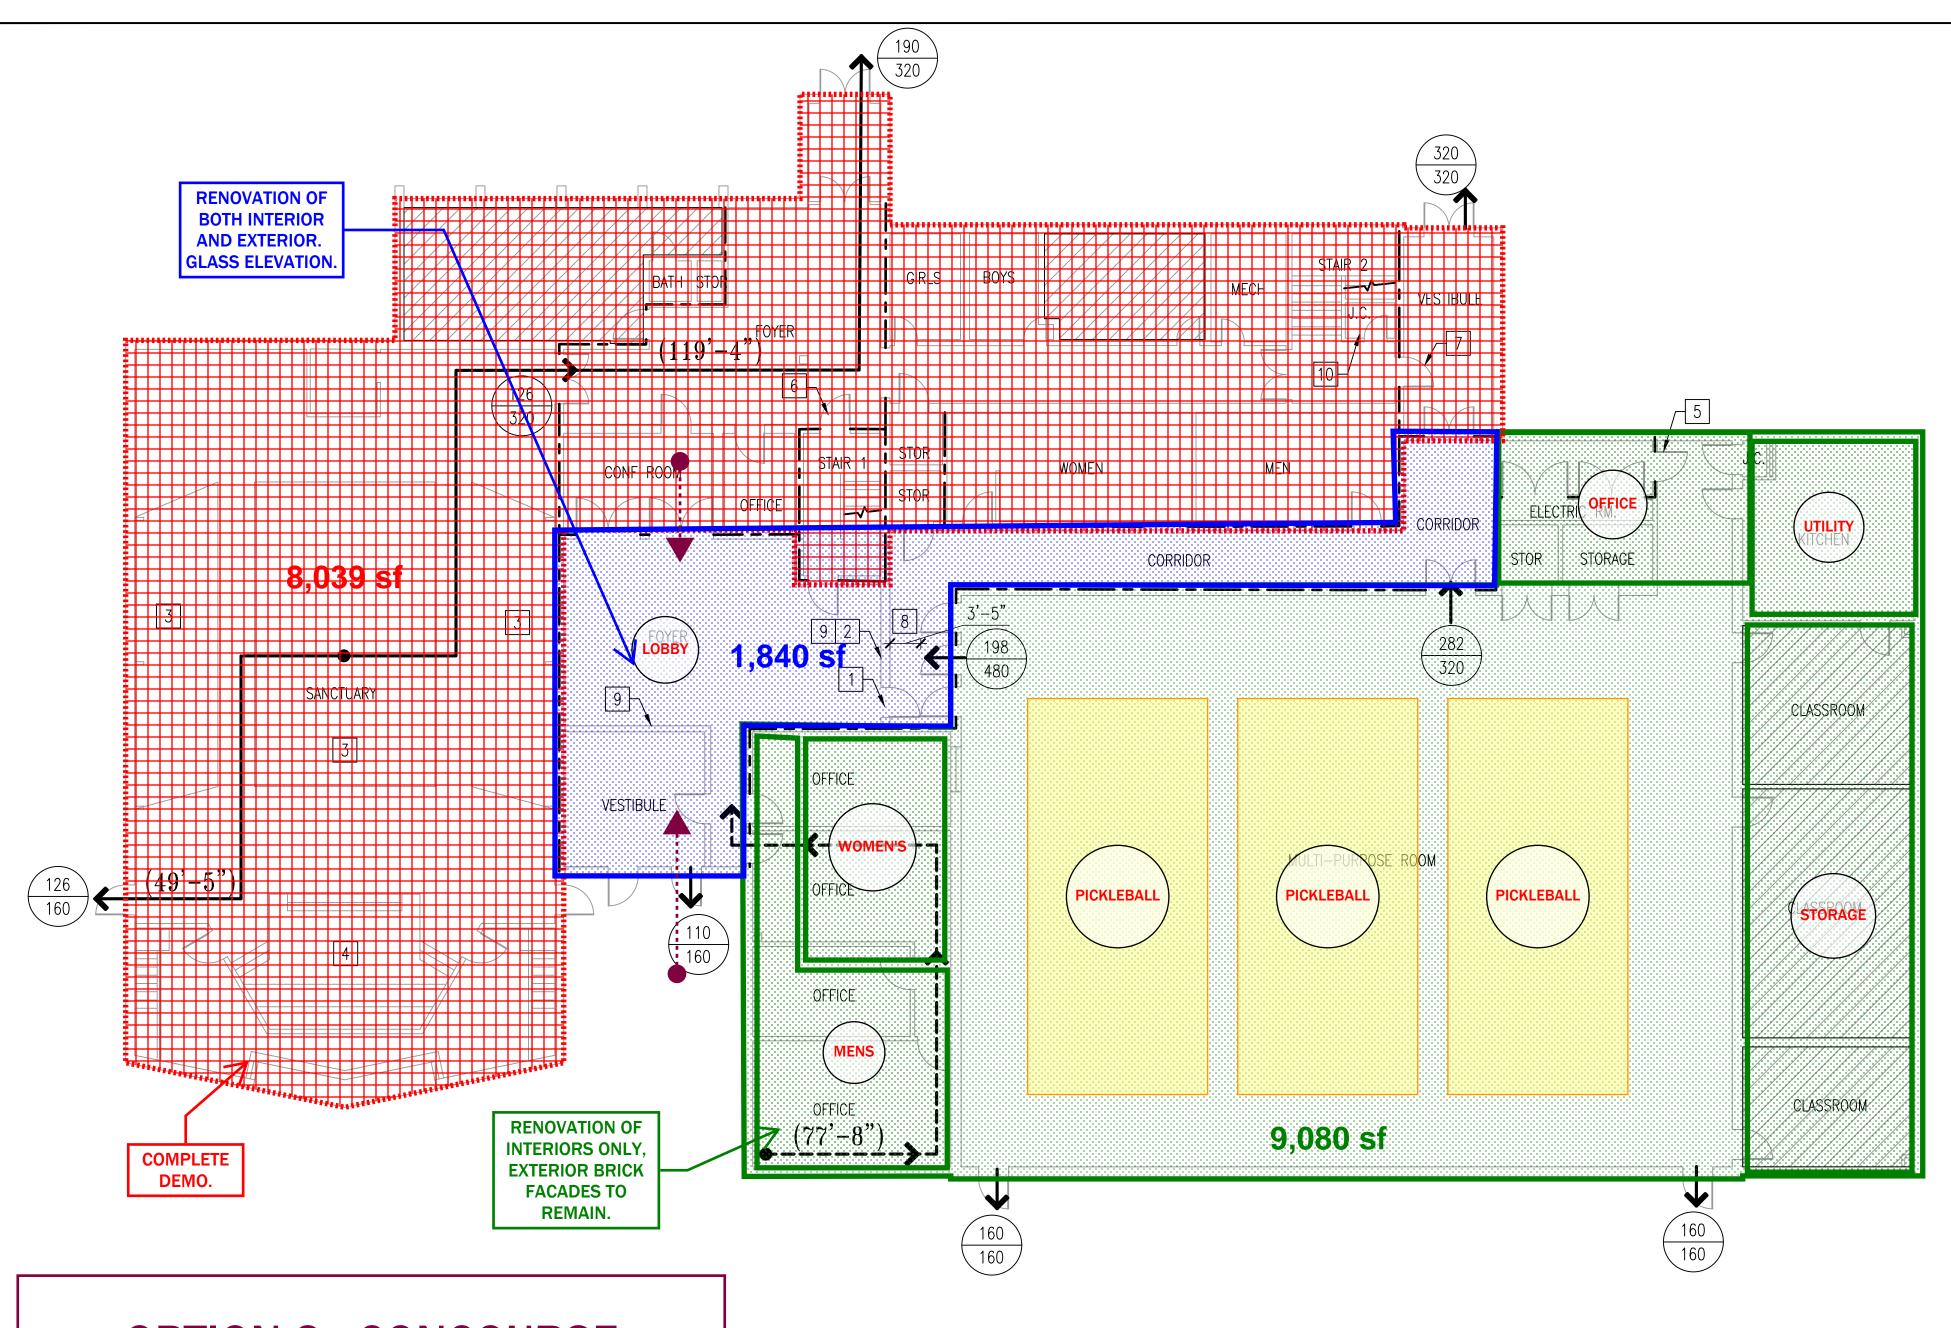
### APPLICABLE CODES

VIRGINIA EXISTING BUILDING CODE (VEBC), 2018 VIRGINIA FIRE PREVENTION CODE. ICC A117.1 AMERICANS WITH DISABILITIES ACT (ADA).


| EGRESS SUMMARY                         |   |  |  |
|--|---|--|--|
| BUILDING CODE                          | NFPA 101 2018 ED REQUIRED<br>IBC 2018 ED REQUIRED |  |  |
| DOOR WIDTH IN INCHES ( MIN 32 INCHES)  | 32 INCHES   |  |  |
| STAIR EGRESS WIDTH IN INCHES (MIN 48") | 48 INCHES / 66 INCHES                             |  |  |
| MIN NUMBER OF EXITS                    | 4   |  |  |
| MAX EXIT TRAVEL DISTANCE IN FEET       | (A-3) 200   |  |  |
| MAX COMMON PATH OF TRAVEL IN FEET      | (A-3) 75  |  |  |
| MAX DEAD-END CORRIDOR LENGTH IN FEET   | 20 FEET   |  |  |
|  |   |  |  |

## GENERAL CODE REVIEW

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- 2. SOME EXISTING PARTITIONS APPEAR TO BE RATED DUE TO PRESENCE OF LABELED DOORS BUT ARE NOT HEREBY

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- OCCUPANT LOAD FROM SECOND STORY = 31. EGRESS THROUGH VESTIBULE.
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- JANITOR'S CLOSET (OR ANY STORAGE OR OTHER FUNCTION) NOT PERMITTED IN STAIRWELLS.

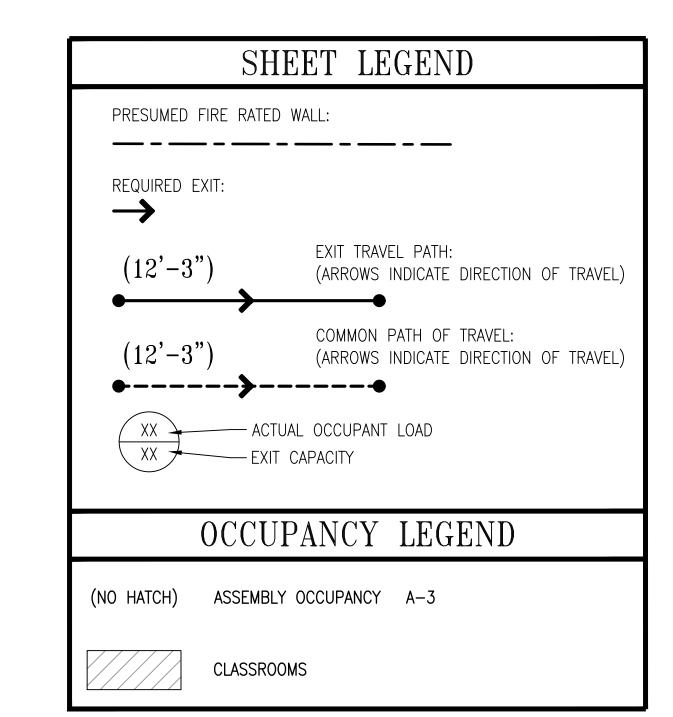

| CODE OCC                              | CUPANT    | LOAD - FI    | LOOR 1    |
|---------------------------------------|-----------|--------------|-----------|
| SPACE FUNCTION                        | AREA      | OCCUPANT /SF | OCCUPANCY |
| SANCTUARY (ASSEMBLY W/ FIXED SEATING) | 3,523 SF  | N/A          | 252       |
| GYMNASIUM /<br>MULTI-PURPOSE          | 5440 SF   | 7            | (700) 800 |
| CLASSROOMS                            | 1757 SF   | 20           | 88        |
| STORAGE                               | 300 SF    | 300          | 1         |
| BUSINESS                              | 7,952 SF  | 150          | 53        |
| TOTAL                                 | 18,702 SF |              | 1,194     |

|  | REVISIONS |  |
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CLIENT INFORMATION

TOWN OF VIENNA PARKS AND RECREATION

FBC CODE REVIEW

KEY PLAN

GRAPHIC SCALES

SCALE: 3/32" = 1'-0"

SIGNATURE

PROFESSIONAL CERTIFICATION. CERTIFY THAT THESE DOCUMENTS WERE PREPARED OR APPROVED BY ME, AND THAT I AM A DULY LICENSED ARCHITECT UNDER THE LAWS OF THE STATE OF MARYLAND, LICENSE NO. 12345 EXPIRATION DATE: XX/XX/XXXX




801 South Caroline Street, Baltimore, Maryland 21231

FIRST FLOOR CODE ANALYSIS PLAN

DRAWING NO.

SCALE: 3/32" = 1'0" SHEET 1 OF 2 DES: **EL** DRAWN: **AJM** CHECK: **EBL** 

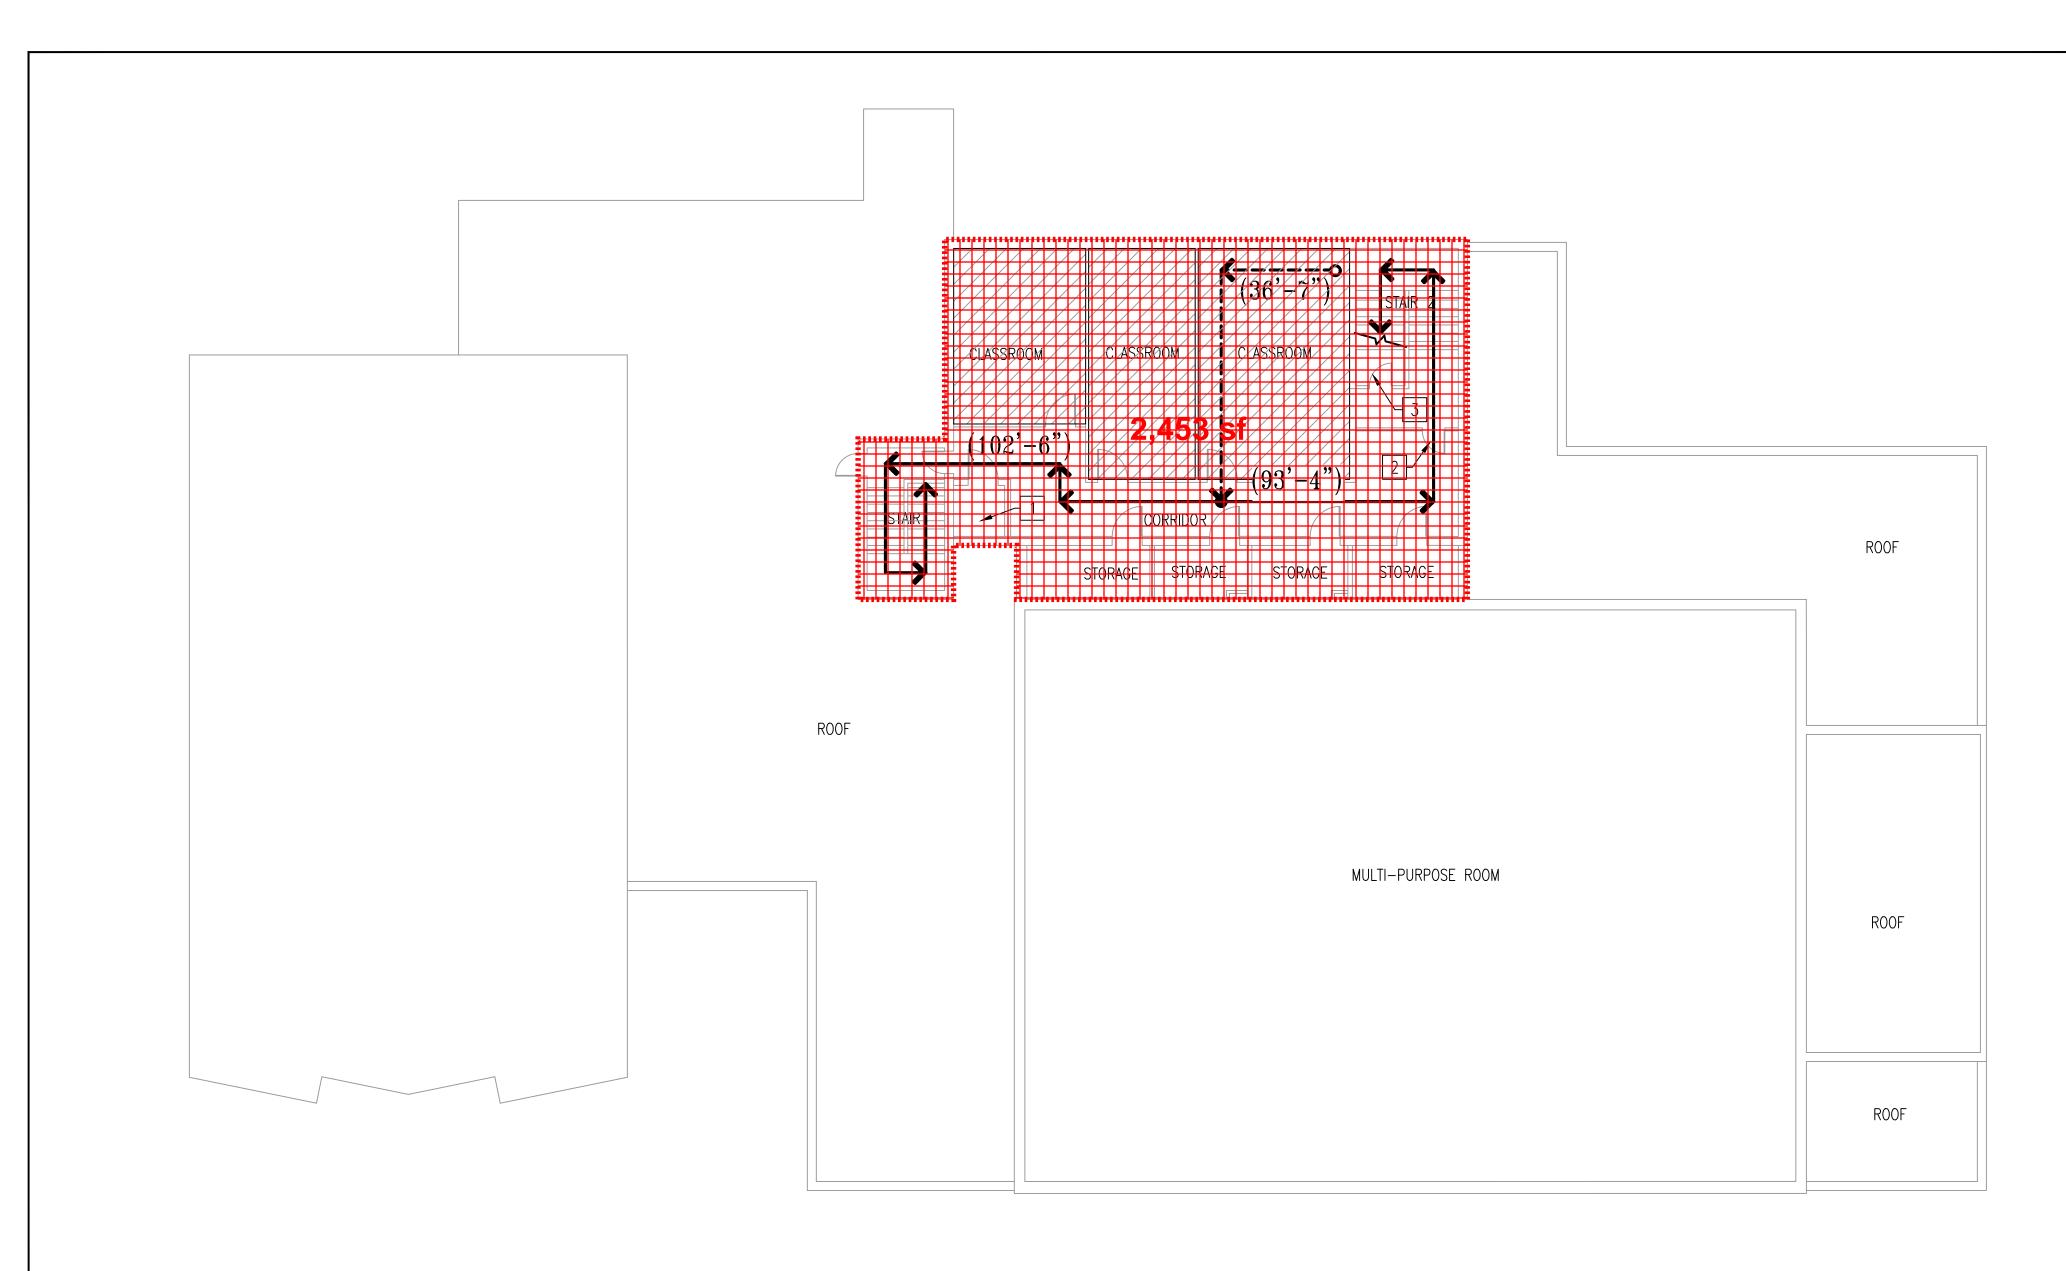



| BUILDING                     | CODE          | SUM     | <u>IMARY</u> | [          |      |
|------------------------------|---------------|---------|--------------|------------|------|
| BUILDING CODE                | 2018 VIRGINIA | UNIFORM | STATEWIDE    | BUILDING ( | CODE |
| FIRE RESISTANCE              | RE            | QUIRED  | PROVIDED     | UL         |      |
| STRUCTURAL FRAME             |               | 0       | 0            |            |      |
| BEARING WALL (EXT/INT)       |               | 0/0     | 0/0          |            |      |
| NON-BEARING EXT WALL X>=10 F | T             | 0       | 0            |            |      |
| FLOOR CONSTRUCTION           |               | 0       | 0            |            |      |
| ROOF CONSTRUCTION            |               | 0       | 0            |            |      |
| STAIR SHAFTS                 |               | 1       | 1            |            |      |
| ELEVATOR & MISC SHAFTS       |               | 1       | 1            |            |      |
| CORRIDOR WALLS               |               | 0       | 0            |            |      |

| BUILDING CODE             | SUMMARY  |
|---------------------------|--|
| BUILDING CODE             | 2018 VIRGINIA UNIFORM<br>STATEWIDE BUILDING CODE |
| TYPE OF CONSTRUCTION      | TYPE VB, NON SPRINKLERED,<br>UNPROTECTED         |
| OCCUPANCY                 | ASSEMBLY A-3<br>ALLOWED PROVIDED                 |
| STORIES                   | 1 2  |
| HEIGHT                    | 40 40  |
| SECOND FLOOR              | 6,000 SF 2,511 SF                                |
| TOTAL GROSS BUILDING AREA | FIRST FLOOR: 18.702 SF<br>SECOND FLOOR: 2,511 SF |
|                           | TOTAL: 21,213 SF                                 |

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|---|--|--|
|   | EGRESS SUMM                            | IARY   |
|   | BUILDING CODE                          | 2018 VIRGINIA UNIFORM STATEWIDE<br>BUILDING CODE |
|   | DOOR WIDTH IN INCHES ( MIN 32 INCHES)  | 32 INCHES  |
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|   | MAX COMMON PATH OF TRAVEL IN FEET      | (A-3) 75   |
|   | MAX DEAD-END CORRIDOR LENGTH IN FEET   | 20 FEET  |
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## GENERAL CODE REVIEW


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## SHEET KEYNOTES

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## APPLICABLE CODES

VIRGINIA EXISTING BUILDING CODE (VEBC), 2018
VIRGINIA FIRE PREVENTION CODE.
ICC A117.1
AMERICANS WITH DISABILITIES ACT (ADA).



| CODE OCC             | CUPANT   | LOAD - FI    | LOOR 1    |
|----------------------|----------|--------------|-----------|
| SPACE FUNCTION       | AREA     | OCCUPANT /SF | OCCUPANCY |
| CLASSROOMS           | 1,022 SF | 20           | 52        |
| STORAGE / MECHANICAL | 305 SF   | 300          | 2         |
| BUSINESS             | 1,184 SF | 150          | 8         |
| TOTAL                | 2,511 SF |              | 62        |
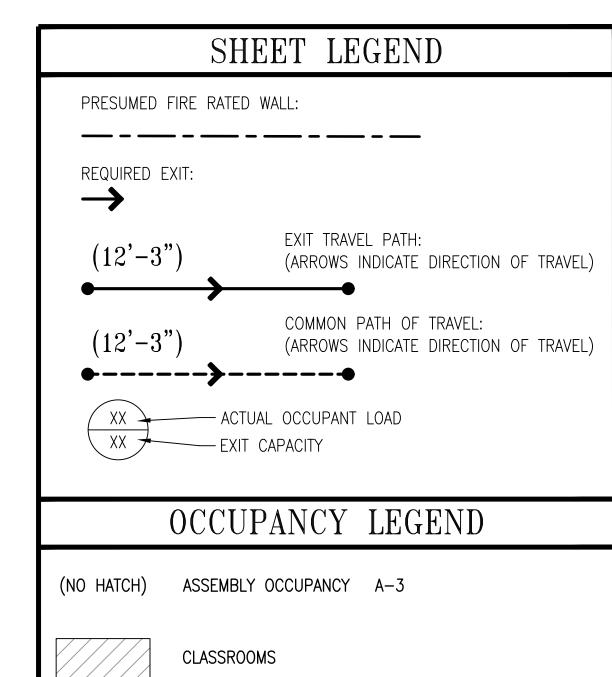
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CLIENT INFORMATION

TOWN OF VIENNA
PARKS AND
RECREATION

FBC CODE REVIEW

| KEY PLAN  |
|---|
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|   |
| GRAPHIC SCALES  0 4' 8' 12' 20'  SCALE: 3/32" = 1'-0" |
|   |
| SIGNATURE   |
|   |
|   |
|   |

A DULY LICENSED ARCHITECT UNDER THE LAWS OF THE STATE OF MARYLAND, LICENSE NO. 12345
EXPIRATION DATE: XX/XX/XXXX

PREPARED OR APPROVED BY ME, AND THAT I AM

PROFESSIONAL CERTIFICATION.

I CERTIFY THAT THESE DOCUMENTS WERE



Whitman, Requardt & Associates, LLP 801 South Caroline Street, Baltimore, Maryland 21231

SECOND FLOOR CODE ANALYSIS PLAN

DRAWING NO.

G1.02

SCALE: 3/32" = 1'0"

DATE: SHEET 2 OF 2

DES: EL DRAWN: AJM CHECK: EBL

